



CONTRACTOR(S) SHALL VERIFY EXISTING CONDITIONS AND CORRELATE DIMENSIONS PRIOR TO PROVIDING THE WORK DETAILED IN THESE DRAWINGS. AND SHALL PROMPTLY NOTIFY THE DESIGNER OF ANY DISCREPANCIES. IT IS A VIOLATION OF THE LAW FOR ANY PERSON UNLESS ACTING UNDER THE DIRECTION OF A LICENSED ARCHITECT TO ALTER THESE PLANS AND SPECIFICATIONS. THIS DOCUMENT CONTAINS PROPERTY INFORMATION AND SHALL NOT BE LOANED OR REPRODUCED, OR ITS CONTENTS DISCLOSED, IN WHOLE OR IN PART, WITHOUT THE PRIOR WRITTEN CONSENT OF BRIAN HERBERT.

COPYRIGHT 2025 GHA ARCHITECTS

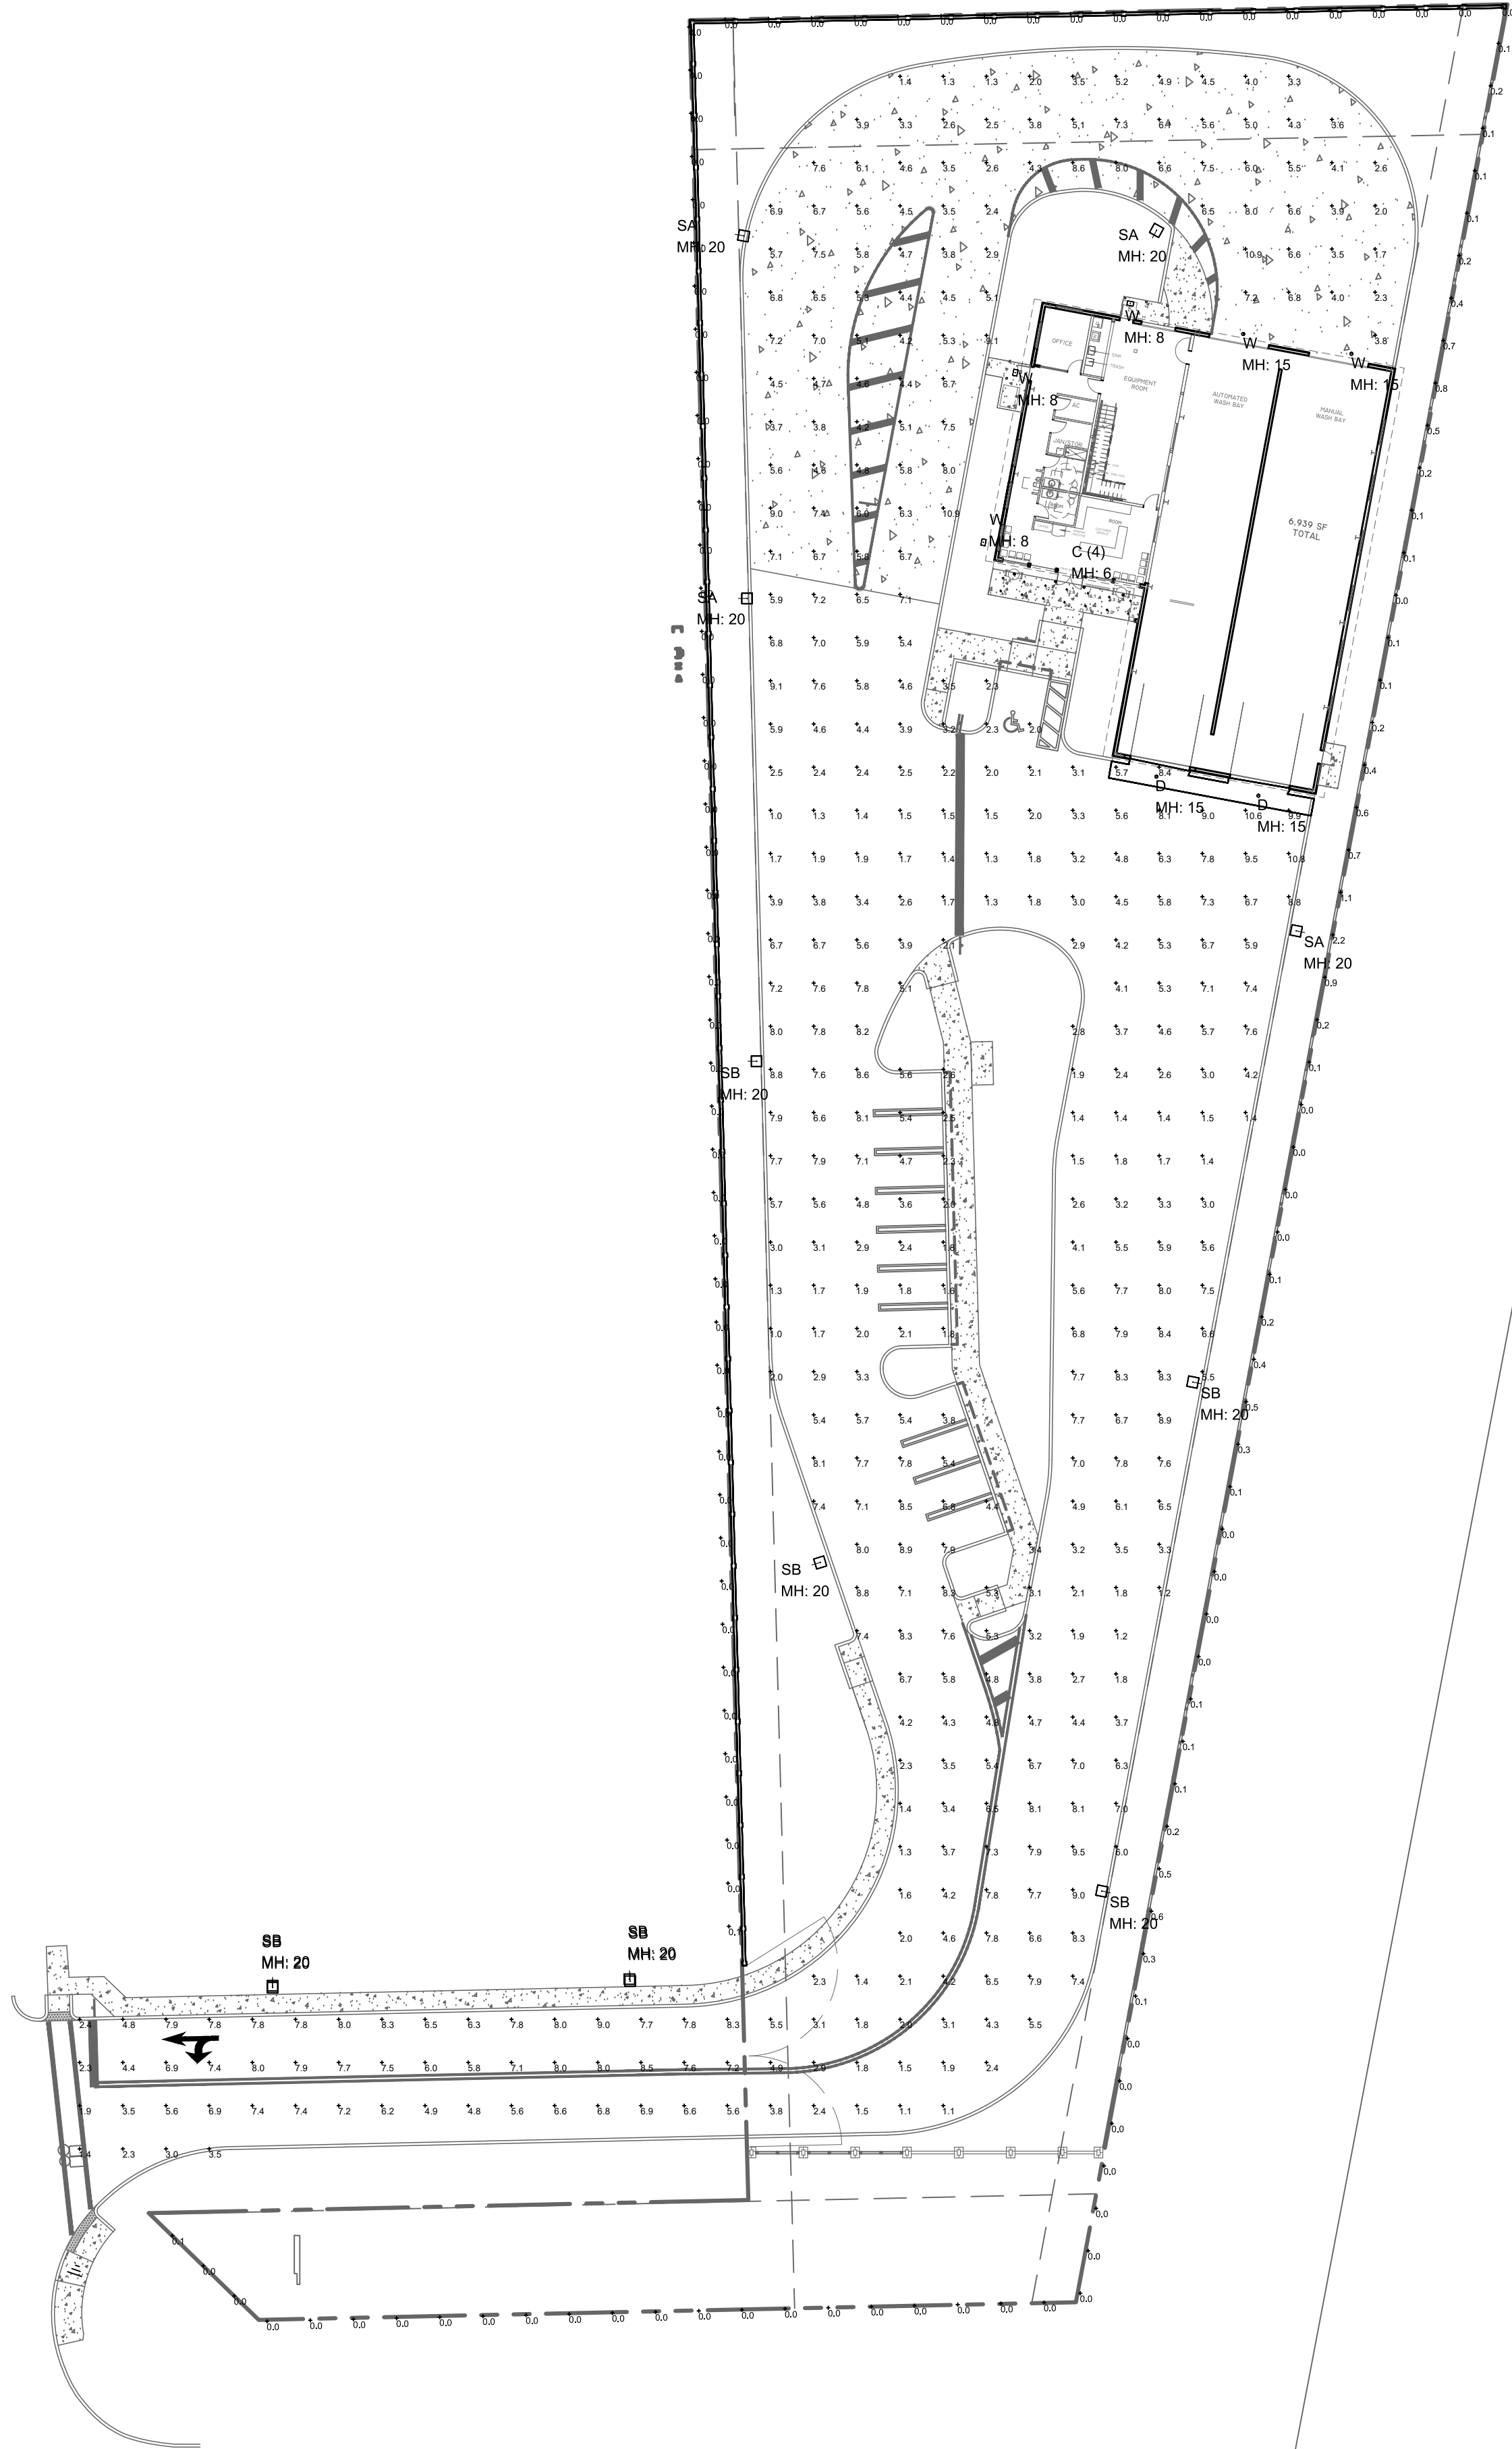

1 SITE LIGHTING PLAN
1" = 30' SCALE

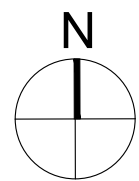

AAC

PZ24-12000026

08.20.2025

JRBW TRUCK WASH										
LIGHTING FIXTURE SCHEDULE										
TYPE	DESCRIPTION	MANUFACTURER	CATALOG NUMBER	VOLT	LAMP COLOR	LUMENS	LAMP TYPE	DIM TYPE	WATTS	NOTES
C	6" LED CYLINDER	PORTFOLIO	LERVM6C100100XXEC8C10259040-6LBM-FINISH	UNV	4000K	765	LED	0-10V	9.8W	NOTE 1
D	CANOPY ROUND LUMINAIRE	MCGRAW-EDISON	TTN-D2-740-U-MQ-FINISH	UNV	4000K	5543	LED	0-10V	42.5W	NOTE 1
SA	LED SITE LUMINAIRE	MCGRAW-EDISON	GALN-SA6C-740-U-T4FT-FINISH-HSS / MA1036-XX	UNV	4000K	30020	LED	0-10V	321W	NOTE 1, 2
SB	LED SITE LUMINAIRE	MCGRAW-EDISON	GALN-SA6C-740-U-T4W-FINISH-HSS / MA1036-XX	UNV	4000K	30159	LED	0-10V	321W	NOTE 1, 2
W	LED WALL PACK	MCGRAW-EDISON	GWC-SA1C-740-U-T4W-FINISH	UNV	4000K	7502	LED	0-10V	59W	NOTE 1
FIXTURE SCHEDULE NOTES										
NOTE 1: ADVISE FINISH										
NOTE 2: FIXTURE MOUNTED ON 20' POLE # US128TIS-9666										
FOR QUESTIONS PERTAINING TO THIS FIXTURE SCHEDULE PLEASE CONTACT MATT MARSHALL @ LIGHTING DYNAMICS-954-812-0346; MMARSHALL@LIGHTINGDYNAMICS.COM										

Photometrics Calculation Software Generated Luminaire Schedule								
Scenario: NORMAL MODE								
Symbol	Qty	Label	Arrangement	Lum. Lumens	Arr. Lum. Lumens	LLF	Lum. Watts	Arr. Watts
1	1	C (4)	GROUP	N.A.	3060	0.900	N.A.	39.2
4	4	D	Single	5543	5543	0.900	42.5	42.5
4	4	SA	Single	30020	30020	0.900	321	321
6	6	SB	Single	30159	30159	0.900	321	321
3	3	W	Single	7502	7502	0.900	59	59

Calculation Summary								
Scenario: NORMAL MODE								
Label	CalcType	Units	Avg	Max	Min	Avg/Min	Max/Min	
NON-RES PROPERTY LINE @ 5FT AFG	Illuminance	Fc	0.18	2.2	0.0	N.A.	N.A.	
RES PROPERTY LINE @ 5FT AFG	Illuminance	Fc	0.00	0.1	0.0	N.A.	N.A.	
ROAD & PARKING	Illuminance	Fc	5.05	10.9	1.0	5.05	10.90	
SITTING AREA	Illuminance	Fc	7.53	16.1	2.0	3.77	8.05	



Portfolio

LER6C/LESQ6C/LSRYM6C/
LSSQYM6C Cylinders

6" Round and Square Cylinder
Surface, Ceiling, Wall, Up/Down, Yoke,
and Stem Mount

Typical Applications
Office • Education • Healthcare • Hospitality • Retail • Residential

2 LABEL C LIGHT
NOT TO SCALE



McGraw-Edison

TTN TopTier Nano

Parking Garage Luminaire

Product Features
BAA TAA

3 LABEL D LIGHT
NOT TO SCALE



McGraw-Edison

GALN Galleon II

Area / Site Luminaire

Product Features
Light Architect BAA FADC

4 LABEL SA & SB LIGHTS
NOT TO SCALE




McGraw-Edison

GWC Galleon Wall

Wall Mount Luminaire

Product Features
Light Architect BAA FADC

5 LABEL W LIGHT
NOT TO SCALE

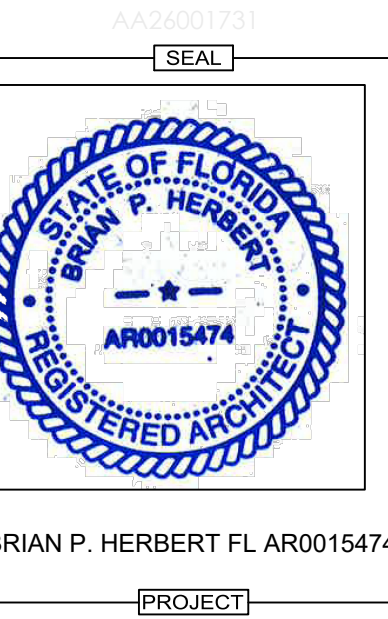

BRIAN P. HERBERT FL AR0015474

ATLANTIC
FLEET WASH

James Argyropoulos
1501 West Atlantic Blvd., Pompano
Beach 33069

OWNER

REVISIONS

No.	Description	Date

PROJECT STATUS

DRC
SUBMITTAL

DATE
7.10.2025

PROJECT NUMBER
7124

DRAWN BY: O.H. AS NOTED
CHECKED BY: B.H.
DRAWING TITLE

SITE LIGHTING
PLAN

DRAWING NUMBER
SL-001

1/22/2025 10:25:30 AM